




TYPICAL STILLING POND LAYOUT  
Scale 1:250

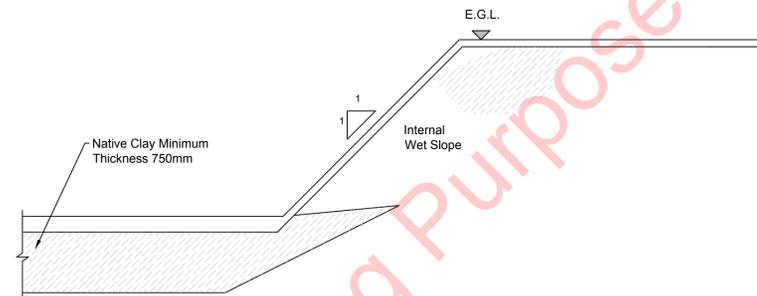

TYPICAL BUND CONSTRUCTION  
(Where Pond is Below Ground Level)  
Scale 1:25

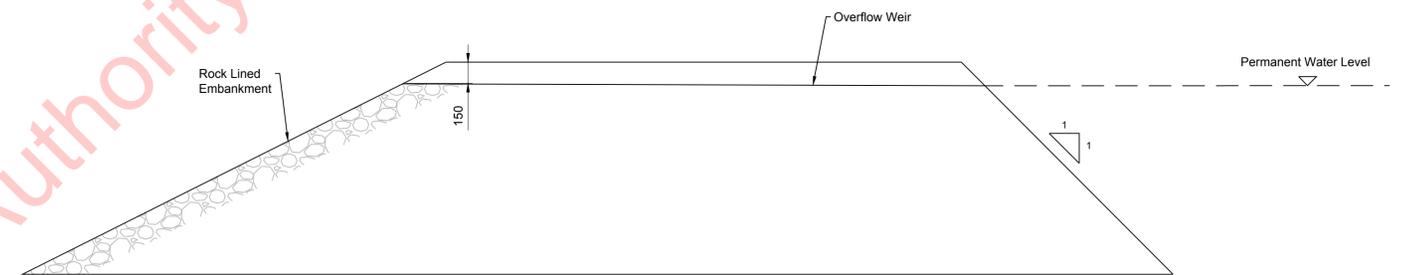

TYPICAL SECTION AT OUTLET  
Scale 1:25

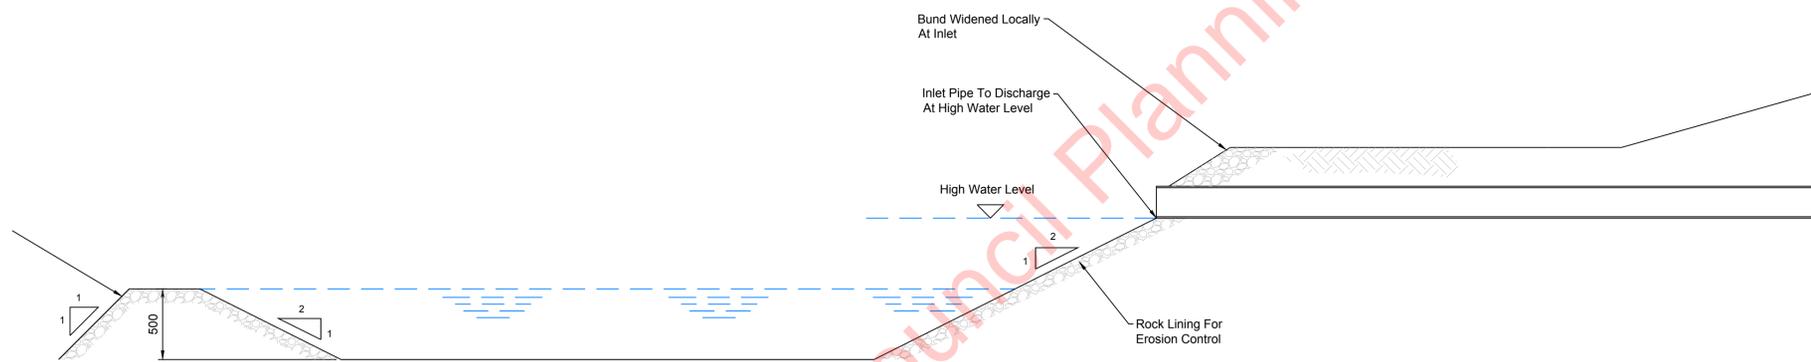

TYPICAL SECTION THROUGH FOREBAY  
Scale 1:25

- NOTES**
1. This drawing should only be read in relation to subject of the title. Other information shown on drawing is to be considered indicative only.
  2. All dimensions are in millimetres unless otherwise stated.
  3. The pond base and sides below the permanent water level should be made impermeable by:  
Cohesive material using native clay or a synthetic liner 1 mm LLDPE.
  4. Bunds in ponds to be constructed from native clay.
  5. Erosion control to be rock lining. Extent to be agreed on site.
  6. Rock lining to be a 125mm thickness of Class 1B material.
  7. Refer to stilling pond schedules for pond sizes.
  8. Swale inlet at 0.15 m below top of pond.
  9. All ponds to be fenced off.

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Rev.	Description	App By	Date
A	ISSUE FOR PLANNING APPLICATION	JH	11.12.19

PROJECT	DERNACART WINDFARM			CLIENT			
SHEET	STILLING POND DETAILS SHEET 1 OF 2			Date	23.09.19	Project number	P1892
				Drawn by	CS	Drawing Number	P1892-0400-0006
				Checked by	EB		Rev
							A

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